


RIGHT ELEVATION SCALE: 1/4"=1"

+36.1 -39.3 PSF

<u>FIN.</u> <u>FL.</u> <u>0'0"</u> ____

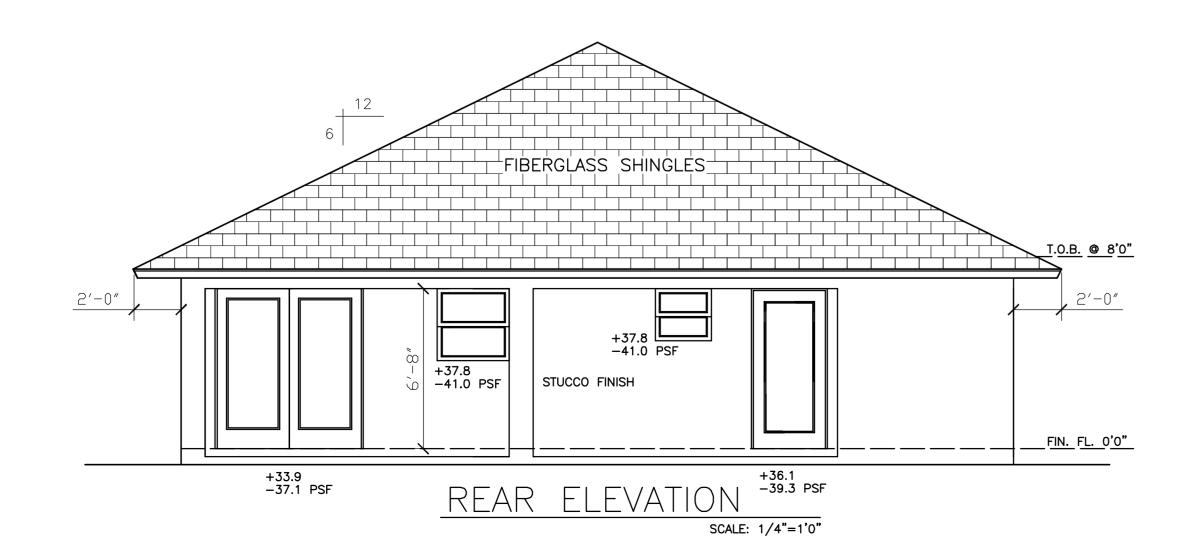

- 1. ALL WOOD IN CONTACT WITH MASONRY SHALL BE PRESSURE TREATED (P.T.)
- 2. METAL STRAPS, CLIPS AND HARDWARE SHALL BE GALVANIZED.
- 3. THE CONTRACTOR, SUBCONTRACTOR, SUPPLIER, ETC., SHALL VERIFY ALL DIMENSIONS AND CONDITIONS AT JOBSITE, PLANS, SPECIFICATIONS, ETC.
- 4. ALL WRITTEN DIMENSIONS ON THESE DRAWINGS TAKE PRECEDENCE OVER SCALED DIMENSIONS.
- 5. STRUCTURAL FEATURES NOT DETAILED ON THESE PLANS WILL BE ADDRESSED BY THE ENGINEER AS CONSTRUCTION PROGRESSES.
- 6. SPLITTING OR CRACKING OF STRUCTURAL COMPONENTS DUE TO INSTALLATION OF HARDWARE IS NOT PREMITTED.
- 7. PRESSURE TREATED (P.T.) FULL LENGTH STUD AGAINST 8"x16" COLUMN BLOCK, WITH PRECUT STUD ADJACENT. ATTACH BOTH STUDS TO POURED COLUMN BLOCK WITH 1/2"x7" HILTI KWIK BOLTS, OR EQUAL @ 24" o.c. AND WITHIN 6" FROM ENDS. USE 3"x3"x1/4" STEEL WASHERS AT EACH BOLT.

WIND DESI	GN DATA	
Ultimate Wind Speed: VASD:	170 mph 132 mph	
Risk Category: Wind Exposure: Enclosure Classification: Internal Pressure Coefficient: Shearwalls & Continuous Load Pat	II C Enclosed 0.18 +/- h Provided	
The Design Wind Speed was used to determine the Components and Cladding Pressures.		
All exterior glazed opening protections shall be Impact Resistant.		

SHEET LEGEND:	
ELEVATIONS	01
FLOOR PLAN	02
FOUNDATION PLAN	03
BEAM & COLUMN PLAN	04
ROOF FRAMING PLAN	05
BY OTHERS:	
ELECTRICAL PLAN	E1
(DESIGN CRITERIA FOR OTHERS) PLUMBING PLAN	P1
(DESIGN CRITERIA FOR OTHERS)	• •
MECHANICAL PLAN (DESIGN CRITERIA FOR OTHERS)	M1
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CONSTRUCTION TYPE: TYPE V-B

OCCUPANCY CLASSIFICATION: RESIDENTIAL USE "R-3"

APPLICABLE CODES:
2020 FLORIDA BUILDING CODE RESIDENTIAL, 7TH EDITION - ASCE 7-16
NFPA70 - 2017 NEC
2020 FLORIDA ENERGY CODE
2020 FLORIDA ACCESSIBILITY CODE
2020 FLORIDA PLUMBING CODE
2020 FLORIDA MECHANICAL CODE

LIVING AREA	983	sq.	ft.
ENTRY	70	sq.	ft.
PATIO/UTILITY ROOM	416	sq.	ft.
TOTAL AREA	1469	Sa.	ft.

DOCUMENTS TO THE ENGINEER AND ARCHITECT BEFORE CONTINUING WORK.

REV # DATE DESCRIPTION

CONTRACTOR SHALL VERIFY ALL DIMENSIONS IN FIELD AND SHALL REPORT ANY DISCREPANCY OR

INCONSISTENCIES WITH THE CONSTRUCTION


SEAL


DATE: 10-26-22 DRAWN BY: TK APPROVED BY: RB SCALE: AS NOTED

SHEET TITLE

SHEET NUMBER

ELEVATIONS

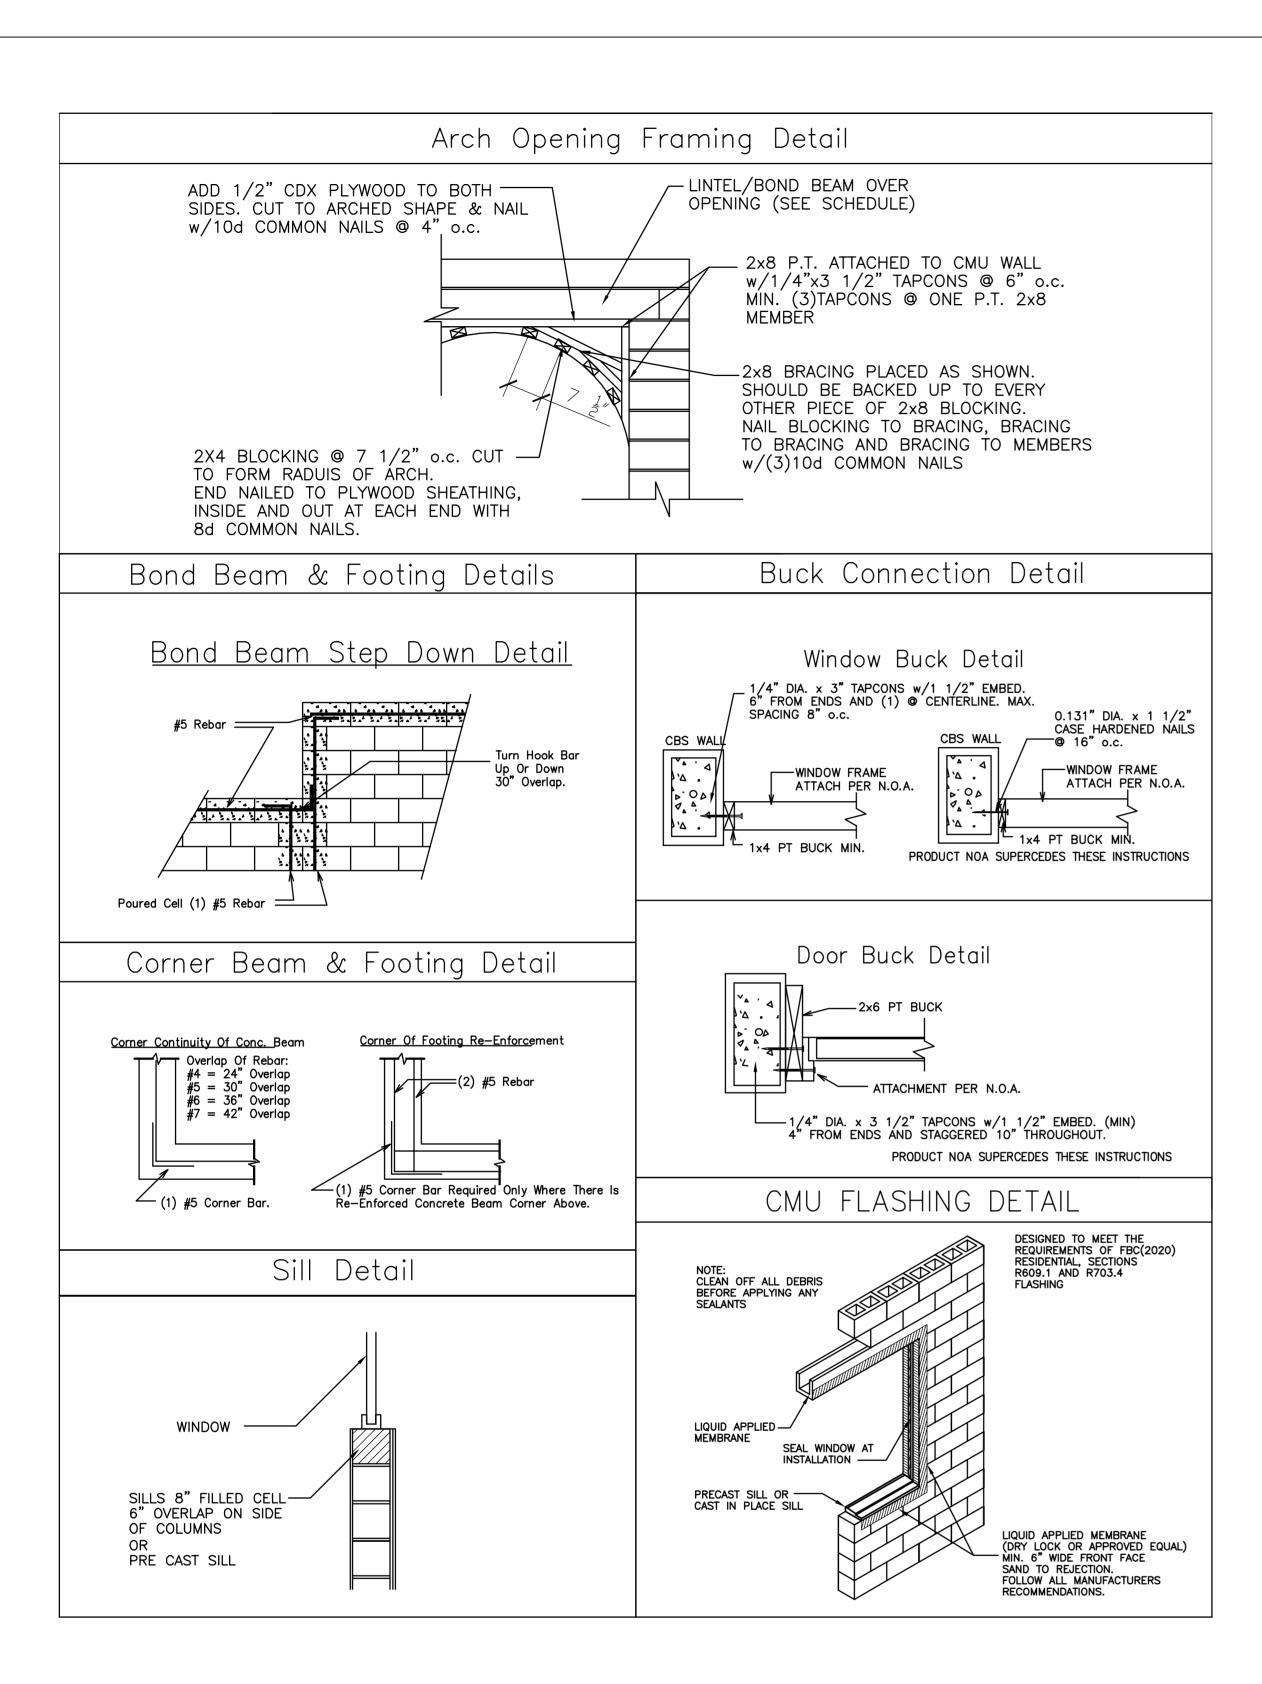

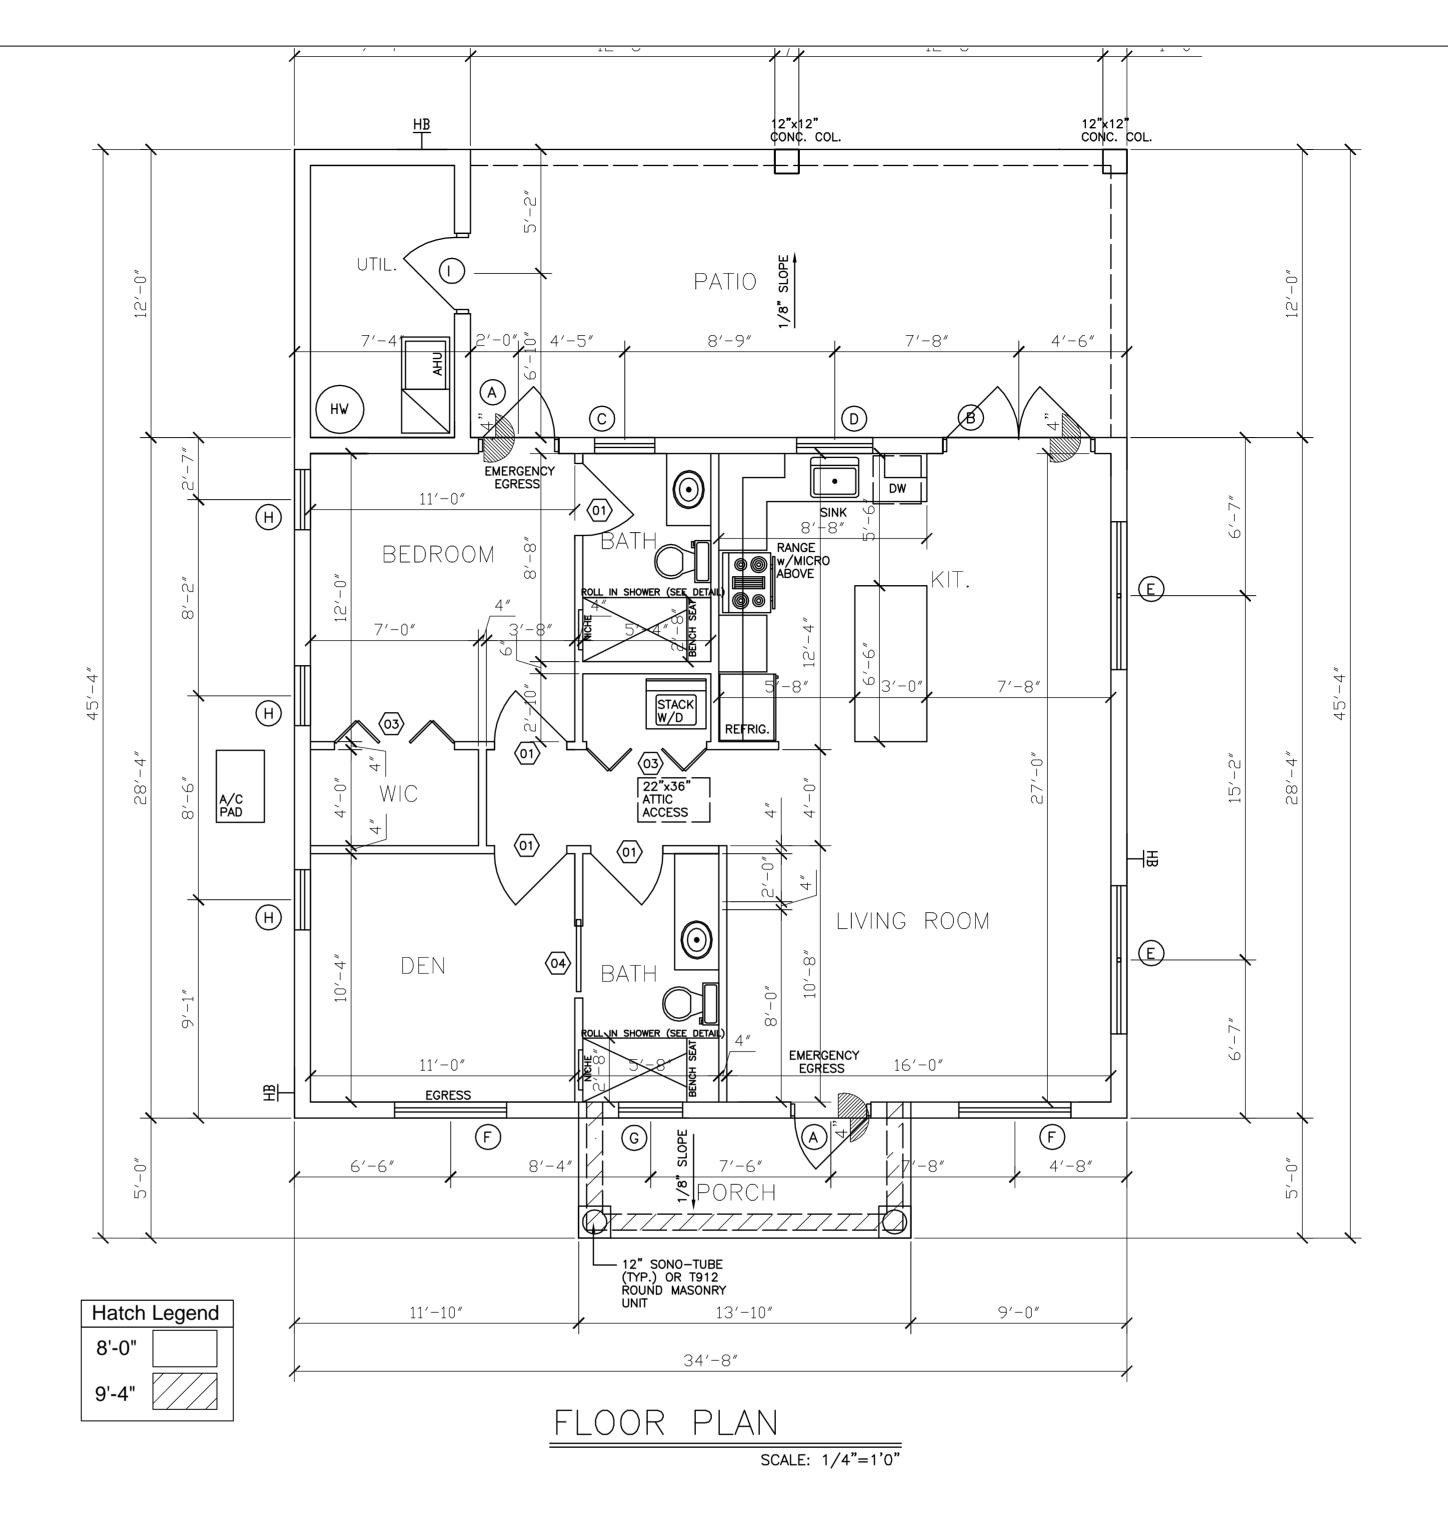

WINDOW & DOOR (EXTERIOR) SCHEDULE					
MARK	LOCATION	TYPE	SIZE	GLASS	REMARKS
A	SEE PLANS	SWING - SINGLE FRENCH DOOR	3'0" x 6'8" V.I.F.	IMPACT	VERIFY M.O. SIZE SEE MANUFACTURER NOA
B	SEE PLANS	SWING - DBL. FRENCH DOORS	6'0" x 6'8" V.I.F.	IMPACT	VERIFY M.O. SIZE SEE MANUFACTURER NOA
\bigcirc	SEE PLANS	SINGLE HUNG H32	27"x26"	IMPACT-TEMP/OBS	VERIFY M.O. SIZE SEE MANUFACTURER NOA
D	SEE PLANS	SINGLE HUNG 23	38"x38"	IMPACT	VERIFY M.O. SIZE SEE MANUFACTURER NOA
E	SEE PLANS	SINGLE HUNG DBL. 25 SH	74"x63"	IMPACT	VERIFY M.O. SIZE SEE MANUFACTURER NOA
F	SEE PLANS	SINGLE HUNG 35 EGRESS	54"x63"	IMPACT	VERIFY M.O. SIZE SEE MANUFACTURER NOA
G	SEE PLANS	FIXED GLASS	30"x24"	IMPACT	VERIFY M.O. SIZE SEE MANUFACTURER NOA
(H)	SEE PLANS	SINGLE HUNG H35	27"x63"	IMPACT	VERIFY M.O. SIZE SEE MANUFACTURER NOA
(I)	SEE PLANS	SWING - SINGLE FIBERGLASS FLUSH	3'0" x 6'8" V.I.F.	IMPACT	VERIFY M.O. SIZE SEE MANUFACTURER NOA

NOTE:

1. ALL WINDOW/DOOR FINISHES AS SELECTED BY INTERIOR DESIGNER/OWNER.

2. VERIFY IN FIELD ALL WINDOW/DOOR SIZES PRIOR TO FABRICATION.

DOOR (INTERIOR) SCHEDULE				
MARK	LOCATION	TYPE	SIZE	REMARKS
(01)	SEE PLANS	SWING - INTERIOR HOLLOW CORE	3'-0" x 6'-8"	
(02)	NOT USED	NOT USED	NOT USED	
(03)	SEE PLANS	BI FOLD - INTERIOR HOLLOW CORE	5'-0" x 6'-8"	
(04)	SEE PLANS	POCKET - INTERIOR HOLLOW CORE	3'-0" x 6'-8"	

NOTE:

1. ALL DOOR FINISHES AS SELECTED BY INTERIOR DESIGNER/OWNER.

2. VERIFY IN FIELD ALL DOOR SIZES PRIOR TO FABRICATION.

REVIEW SET 10-26-22 NOT FOR CONSTRUCTION FLOOR PLAN

DATE: 10-26-22 DRAWN BY: TK A ROVED

BY: RB

SCALE: AS NOTED

SHEET TITLE

SHEET NUMBER

CONTRACTOR SHALL VERIFY ALL DIMENSIONS IN FIELD AND SHALL REPORT ANY DISCREPANCY OR INCONSISTENCIES WITH THE CONSTRUCTION

DOCUMENTS TO THE ENGINEER AND ARCHITECT BEFORE CONTINUING WORK.

REV # DATE DESCRIPTION